


Safety is a Part
of Your Contract

GENERAL NOTES:


1. ALL REFERENCES TO WALL LINE (W/L) REFER TO THE CENTERLINE OF THE EXISTING SHEET PILE WALL ON THE ORLEANS LEVEE OF THE 17TH STREET CANAL. STATIONING ALONG THE WALL IS BASED ON THE THEORETICAL WIDTH OF THE SHEETS (BZ12.1L AND HOESCH 12 ARE 22.64'; PMA-22 IS 19.625').
2. ELEVATIONS REFER TO NATIONAL GEODETIC VERTICAL DATUM (N.G.V.D.). ELEVATION AT U.S.C.E. MONUMENT 14 IS 8.77 N.G.V.D..
3. NORMAL WATER SURFACE ELEVATION RANGE IS FROM EL.1.5 TO EL.2.0 (N.G.V.D.).
4. REFERENCES TO THE PROTECTED SIDE OF THE LEVEE REFER TO THE LAND SIDE OF THE LEVEE. REFERENCES TO THE FLOOD SIDE OF THE LEVEE REFER TO THE CANAL OR LAKE SIDE OF THE LEVEE.
5. THE CONTRACTOR SHALL WELD 1/2 IN. BY 8 IN. STUD ANCHORS ON THE EXISTING SHEET PILE AS INDICATED AND SPECIFIED IN THE SPECIFICATIONS.

6. THE CONTRACTOR SHALL NOTE THE CLOSE PROXIMITY OF RESIDENCES, TREES, AND UTILITIES ALONG THE ENTIRE LENGTH OF THE PROJECT SITE. HE SHALL EXERCISE EXTREME CAUTION AT ALL TIMES WHEN WORKING ON THE LEVEE AND HE SHALL BE RESPONSIBLE FOR THE REPAIR OF ANY DAMAGE RESULTING FROM HIS OPERATIONS.
7. CONTRACTOR SHALL PROVIDE, ERECT, AND MAINTAIN A SAFETY FENCE AROUND THE CONSTRUCTION RIGHT-OF-WAY. SEE SPECIAL CLAUSE "SAFETY PROVISIONS".
8. SEE DRAWING 5 FOR BENCH MARK INFORMATION.

| OBSTRUCTIONS TO R/W | | |
|---------------------------|------------------------------|-------------|
| W/L STATION (APPROXIMATE) | ITEM AND OWNER | DISPOSITION |
| 99+71 | U.S. SPRINT FIBER OPTIC LINE | DWG. NO. 2 |
| 35+82 | L.P. & L. POWER LINE | DWG. NO. 4 |

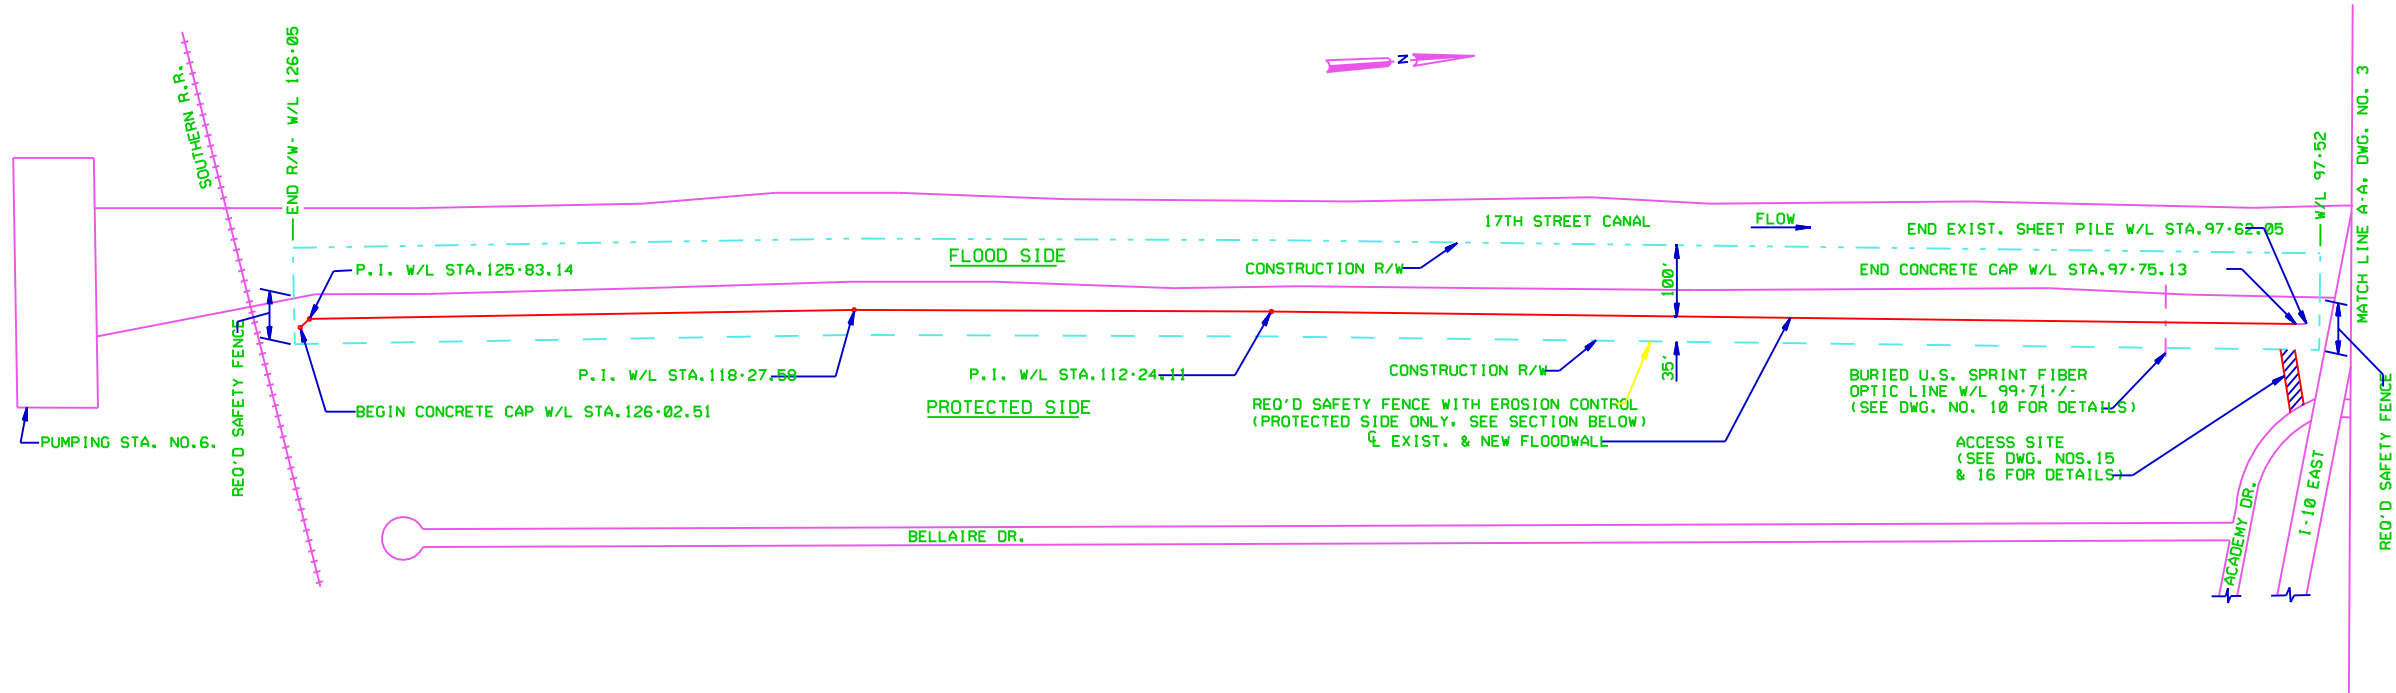

PLAN
SCALE 1" = 100'-0"

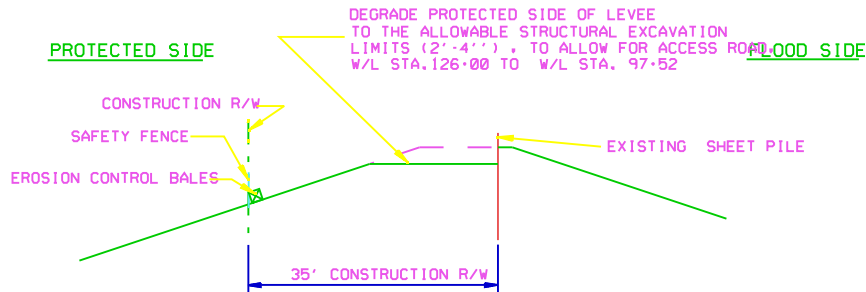

EXCAVATED MATERIAL MUST BE HAULED IN ACCORDANCE WITH C2C OF THE SPECIFICATIONS AND STORED FOR REUSE IN ACCORDANCE WITH SPECIAL CLAUSE "OFFSITE STORAGE".

STA. 116+00 TO STA. 98+00 SHOWN. OTHERS AREAS SIMILAR.

ACCESS AND STORAGE DETAILS

STA. 126+03 TO STA. 97+52
SCALE 1" = 10'-0"
ACCESS NOT SHOWN FOR CLARITY

LEGEND


- SHEET PILE TO BE CAPPED
- SHEET PILE LEFT UNCAPPED
- CONSTRUCTION R/W
- UTILITY
- CONSTR. R/W, SAFETY FENCE, EROSION CONTROL
- CONSTR. R/W AND SAFETY FENCE

SCALE: 1" = 100'

100' 0 100' 200' 300' 400'

SCALE: 1" = 10'

10' 0 10' 20' 30' 40'

| | | | | |
|--|-------------|---|---|---|
|  | | CHANGED NOTE B FROM REMOVAL OF COAL TAR EPOXY TO STUD ANCHORS/AMEND. #2 | 21 MAY 1993 | RJG |
| SYMBOL | DESCRIPTION | | DATE | APPROVED |
| REVISIONS | | | | |
|  U.S. ARMY ENGINEER DISTRICT, NEW ORLEANS CORPS OF ENGINEERS NEW ORLEANS, LOUISIANA | | | | |
| BOARD OF LEVEE COMMISSIONERS ORLEANS LEVEE DISTRICT NEW ORLEANS, LOUISIANA | | | MODJESKI & MASTERS INC. NEW ORLEANS, LOUISIANA | |
| LAKE PONTCHARTRAIN, LA. AND VICINITY HIGH LEVEL PLAN 17TH STREET CANAL EXCAVATION AND FLOODWALL PROTECTION CAPPING OF FLOODWALLS EAST SIDE LEVEE IMPROVEMENTS PLAN-1 AND GENERAL NOTES | | | | |
| DESIGNED BY: F.S. DRAWN BY: P.M.R. CHECKED BY: M.L.S. | | DATE: NOV. 1992 CADD FILE #020002.DWG | PLOT SCALE: 1200 SOLICITATION NO. DACW29-93-B-0025 | PLOT DATE: APR 1993 FILE NO. H-4-40208 DWG. 2 OF 16 |
| SUBMITTED BY: V. B. CONWAY MODJESKI & MASTERS INC. DESIGN ENGINEER | | | | |

